

| Sheet List | |
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| Sheet | |
| Number | Sheet Name |

| A000 | Title Sheet |
|------|-----------------------------------|
| A001 | Site Plan |
| A002 | General Building Notes |
| A003 | Bldg Codes/Phase Descriptions |
| A100 | Basement Plan -Stud Wall |
| A101 | 1st Floor Plan |
| A102 | Existing Second Floor Plan |
| A111 | 1st Floor Plan - Ceiling |
| A200 | West Elevation |
| A201 | South Elevation |
| A202 | East Elevation |
| A203 | North Elevation |
| A300 | Building Section |
| A301 | Building Section |
| A302 | Building Section |
| A400 | Wall Sections and Detailed Plans |
| A401 | Building Details - Exterior Walls |
| A402 | Building Details - Interior Walls |
| A500 | Door Schedule |
| A501 | Door Details |
| A502 | Room Schedule |

| Sheet List | | |
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| Sheet | | |
| Number | Sheet Name | |

| P101 | Plumbing Notes |
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| P102 | Plumbing Notes |
| P200 | Plumbing Basement Plan |
| P201 | Plumbing First Floor Plan |
| P202 | Plumbing Second Floor Plan |
| M101 | Mechanical Notes |
| M102 | Mechanical Details |
| M200 | Mechanical Basement Floor Plan |
| M201 | Mechanical First Floor Plan |
| M202 | Mechanical Second Floor Plan |
| E101 | Electrical Notes |
| E102 | Electrical Legends |
| E103 | Electrical Legends |
| E104 | One Line Diagam |
| E105 | Electrical Panelboards |
| E106 | Electrical Legends |
| E107 | Electrical Legends |
| E200 | Power Basement Plan |
| E201 | Power First Floor Plan |
| E202 | Power Second Floor Plan |
| E300 | Lighting Basement |
| E301 | Lighting First Floor Plan |
| E302 | Lighting Second Floor Plan |
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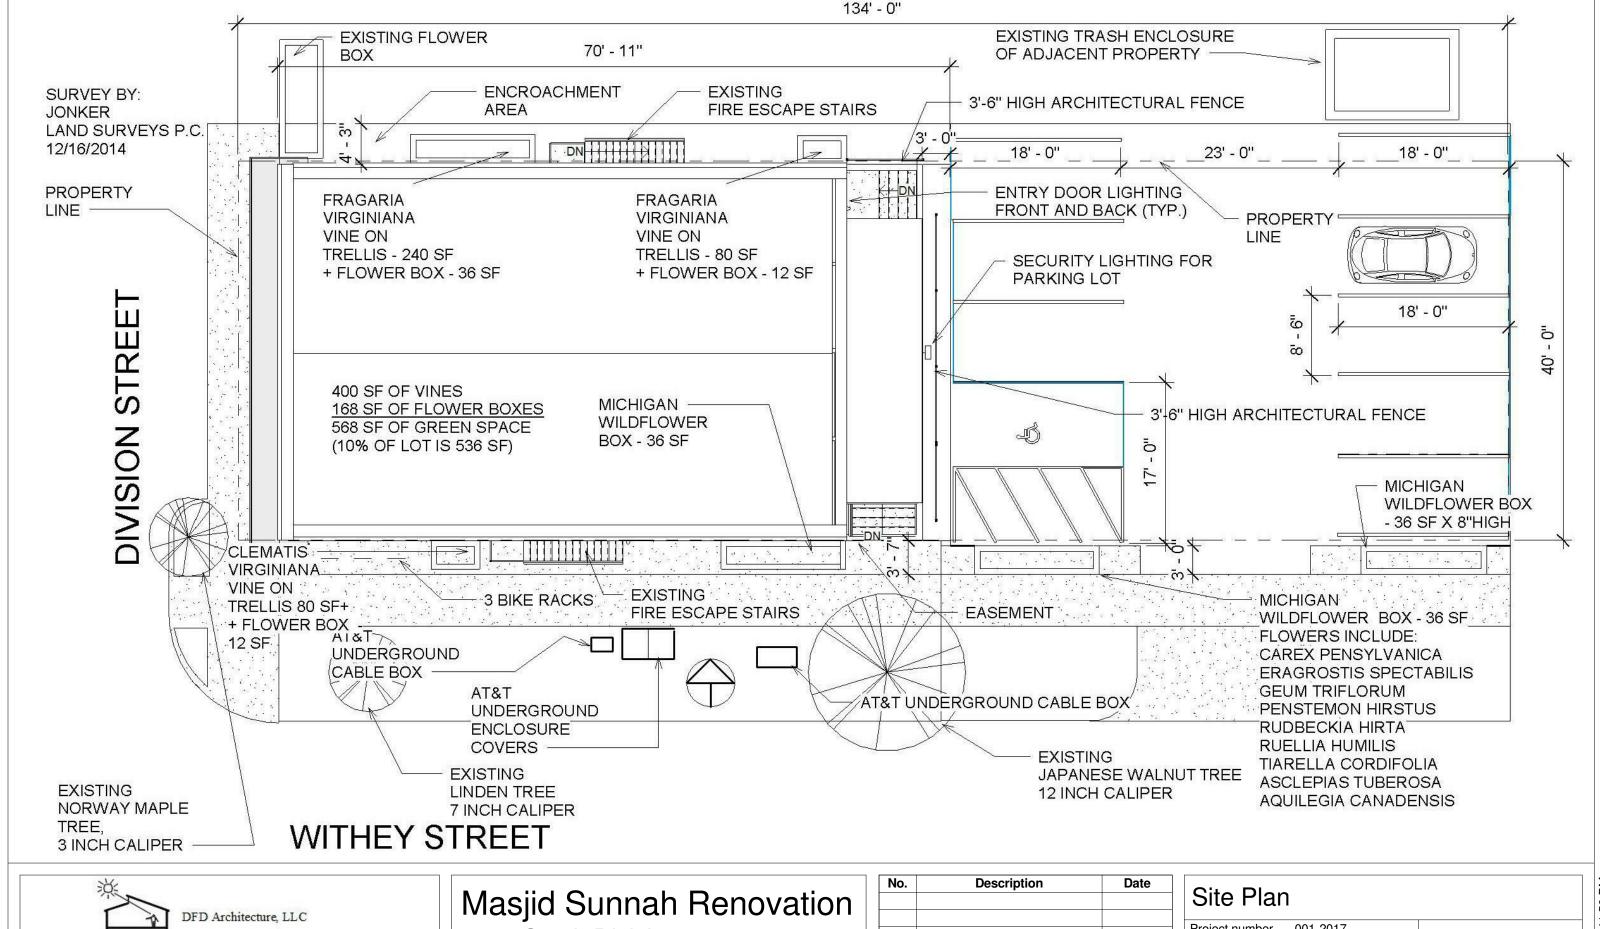


DFD Architecture, LLC

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- 1. CONTRACTOR SHALL PROVIDE FIRE EXTINGUISHERS PER CODE, INCLUDING NFPA 10, AND AS DIRECTED BY THE LOCAL FIRE DEPARTMENT THROUGHOUT BUILDING. FIRE EXTINGUISHER CABINETS SHALL NOT PROJECT MORE THAN 4" BEYOND THE FACE OF THE WALL. RECESSED FIRE EXTINGUISHER CABINETS IN FIRE RATED WALLS SHALL HAVE THE SAME FIRE RATING AS THE WALL.
- 2. DIMENSIONS TO EXTERIOR WALLS ARE ASSUMED FACE OF FOUNDATION WALL UNLESS OTHERWISE NOTED. ALL INTERIOR DIMENSIONS ARE TAKEN FROM FACE OF FINISH WALL. ALL EXTERIOR DIMENSIONS ARE TO FACE OF SHEATHING, UNLESS OTHERWISE NOTED.
- 3. CONTRACTOR IS TO VERIFY ALL DIMENSIONS PRIOR TO THE START OF CONSTRUCTION AND NOTIFY OWNER'S REPRESENTATIVE OF ANY DIFFERENCES PRIOR TO BEGINNING OF CONSTRUCTION.
- 4. BEFORE SUBMITTING BID, EXAMINE ALL DRAWINGS RELATED TO THE WORK, BECOME FULLY INFORMED AS TO THE EXTENT AND CHARACTER OF THE WORK OF ALL TRADES AND ITS RELATION TO THE WORK UNDER THE CONTRACT. NO CONSIDERATION WILL BE GIVEN FOR ALLEGED MISUNDERSTANDING OF THE MATERIALS TO BE FURNISHED OR THE WORK TO BE DONE.
- 5. THE CONTRACTOR SHALL BE RESPONSIBLE FOR VISITING THE SITE TO VERIFY EXISTING CONDITIONS PRIOR TO SUBMITTING HIS BID.
- 6. CONTRACTOR SHALL REVIEW AND SUBMIT SHOP DRAWINGS SUFFICIENTLY IN ADVANCE OF THE WORK TO ALLOW PROPER TIME FOR REVIEW. MATERIALS SHALL NOT BE FABRICATED OR DELIVERED TO THE SITE BEFORE THE SHOP DRAWINGS HAVE BEEN REVIEWED AND APPROVED BY THE OWNER'S REPRESENTATIVE.
- 7. ALL SUBSTITUTE MANUFACTURERS, EQUIPMENT, MATERIALS AND PRODUCTS SHALL BE APPROVED BY THE OWNERS REPRESENTATIVE. THE CONTRACTOR IS RESPONSIBLE FOR ALL ASSOCIATED COSTS TO ANY AND ALL BUILDING COMPONENTS THAT ARE AFFECTED BY THE SUBSTITUTIONS. ADDITIONAL COSTS INCLUDE ANY REDESIGN THAT IS REQUIRED DUE TO THE SUBSTITUTION.
- 8. DO NOT SCALE DRAWINGS, THE DIMENSIONS SHOWN ON THE PLANS MAY VARY FROM THE ACTUAL DIMENSIONS IN THE FIELD, IT IS, THEREFORE, IMPERATIVE THAT THE CONTRACTOR, PRIOR TO COMMENCEMENT OF WORK, TAKE EXACT MEASUREMENTS TO VERIFY ALL DIMENSIONS SHOWN ON THE PLANS AND SHOP DRAWINGS. ALL WORKING DRAWINGS PREPARED BY THE CONTRACTOR SHALL INCLUDE A STATEMENT CERTIFYING THAT THOSE DRAWINGS HAVE BEEN PREPARED IN ACCORDANCE WITH THE FIELD MEASURED DIMENSIONS.
- 9. THE CONTRACTOR SHALL NOTIFY THE OWNER'S REPRESENTATIVES OF ANY AND ALL DISCREPANCIES BETWEEN FIELD CONDITIONS AND THE CONTRACT DOCUMENTS BEFORE PROCEEDING WITH THAT PORTION OF THE WORK. FAILURE TO NOTIFY THE ARCHITECT WILL NOT RELIEVE THE CONTRACTOR OF RESPONSIBILITY TO COMPLY WITH THE DOCUMENTS. THE CONTRACTOR SHALL CORRECT ANY AND ALL WORK ARISING FROM SUCH FAILURE AND COORDINATE DISCREPANCIES TO THE SATISFACTION OF THE OWNER'S REPRESENTATIVES WITHOUT ADDITIONAL COST TO THE OWNER.
- 10. THE LOCATION OF ALL ITEMS SHOWN ON THE DRAWINGS OR CALLED FOR IN THE SPECIFICATIONS THAT ARE NOT DEFINITELY FIXED BY DIMENSIONS ARE DIAGRAMMATIC. THE EXACT LOCATIONS NECESSARY TO SECURE THE BEST CONDITIONS AND RESULTS MUST BE DETERMINED AT THE PROJECT AND SHALL HAVE THE APPROVAL OF THE OWNER'S REPRESENTATIVE BEFORE BEING INSTALLED. DO NOT SCALE DRAWINGS. THE CONTRACTOR SHALL PROVIDE, WITHOUT ADDITIONAL REMUNERATION, ANY COMPONENT NECESSARY TO COMPLETE THE SYSTEMS IN ACCORDANCE WITH THE BEST PRACTICE OF THE TRADE.
- 11. DATA, COMMUNICATIONS CABLE, SECURITY SYSTEMS MAY BE PROVIDED BY THE OWNER'S VENDORS. HOWEVER THE CONTRACTOR SHALL PROVIDE APPROPRIATE WALL BOXES, CONDUIT WITH PULL STRINGS, ETC. AS REQ'D FOR ROUGH-IN CONDITIONS. ELECTRICAL CONTRACTOR IS RESPONSIBLE FOR COORDINATING THE LOCATION OF THESE ITEMS WITH THE OWNER'S VENDORS, ASAAG COMPLIANCE SHALL APPLY.

- 12. MECHANICAL, ELECTRICAL, AND PLUMBING, ARE SCHEMATIC IN NATURE. THEREFORE, IT IS THE CONTRACTOR'S RESPONSIBILITY TO COORDINATE THE ROUTING OF THESE TRADES, AS WELL AS, THE OWNER'S WORK TO ASSURE THAT THESE SYSTEMS DO NOT CONFLICT WITH THE ARCHITECTURAL AND STRUCTURAL ELEMENTS OF THE BUILDING. IF THE GENERAL CONTRACTOR CANNOT ROUTE THESE ITEMS TO AVOID A CONFLICT, THEN THEY SHALL NOTIFY THE ARCHITECT PRIOR TO STARTING ANY RELATED WORK.
- 13. CONTRACTOR TO PROTECT ALL NEW WORK DURING CONSTRUCTION AND REPLACE DAMAGED MATERIAL IN KIND.
- 14. ALL GYPSUM WALL BOARD TO BE TAPED AND SANDED AT INTERSECTION OF CONSTRUCTION (NO "J" MOLD)
- 15. PROVIDE CORNER BEAD AT ALL EXPOSED GYPSUM WALL BOARD CORNERS.
- 16. CONTRACTOR SHALL PROVIDE ALL MATERIALS, FABRICATION, LABOR AND SUPERVISION, ERECTION EQUIPMENT AND APPLIANCES REQUIRED TO INSTALL ALL EQUIPMENT SHOWN ON DRAWINGS AND AS INDICATED IN THE SPECIFICATIONS.
- 17. THE TERM "PROVIDE" SHALL MEAN "FURNISH AND INSTALL, INCLUDING ALL LABOR, EQUIPMENT, MATERIALS AND PRODUCTS," UNLESS OTHERWISE NOTED.
- 18. CONTRACTOR SHALL COORDINATE HIS WORK WITH THE OWNER SO THAT THERE IS NO INTERFERENCE WITH OWNER'S PERSONAL OR WORK SCHEDULE.
- 19. ALL WORK SHALL COMPLY WITH RULES AND REGULATIONS OF ALL GOVERNMENTAL AGENCIES HAVING JURISDICTION.
- 20. THE CONTRACTOR SHALL BE RESPONSIBLE FOR INITIATING, MAINTAINING AND SUPERVISING ALL SAFETY PRECAUTIONS AND PROGRAMS IN CONNECTION WITH THE PERFORMANCE OF THE CONTRACT.
- 21. SAFE WORKING CONDITIONS AND ALL SAFETY REQUIREMENTS ESTABLISHED BY JURISDICTIONAL AGENCIES AND/OR THE OWNER SHALL BE OBSERVED. WHERE CONFLICTS EXIST, THE MORE STRINGENT REQUIREMENTS SHALL APPLY. CARE MUST BE EXERCISED TO AVOID ENDANGERING PERSONNEL OR THE STRUCTURE.
- 22. CONTRACTOR SHALL REMOVE AND LEGALLY DISPOSE OF ALL DEBRIS FROM SITE AND LEAVE THE WORK AREA BROOM CLEAN ON A DAILY BASIS AND PROVIDE DUMPSTER SERVICE. PLACE DUMPSTER AS DIRECTED BY THE "OWNER'S REPRESENTATIVE".
- 23. CONTRACTOR SHALL FURNISH ALL SCAFFOLDING, HOISTING EQUIPMENT AND ANY OTHER EQUIPMENT THAT MAY BE REQUIRED TO PERFORM THE WORK INDICATED IN A SAFE AND ORDERLY MANNER.
- 24. THE CONTRACTOR SHALL TAKE ALL NECESSARY PRECAUTIONS TO INSURE AGAINST DAMAGE TO EXISTING WORK TO REMAIN IN PLACE. ANY DAMAGE TO SUCH WORK SHALL BE REPAIRED OR REPLACED TO THE SATISFACTION OF THE OWNER AT NO ADDITIONAL COST.
- 25. THE CONTRACTORS & SUB CONTRACTORS SHALL BE RESPONSIBLE FOR SECURING & PAYING FOR ALL PERMITS, APPROVALS, & CERTIFICATES NECESSARY FOR COMPLETION OF THE PROJECT.
- 26. ALL NEW MATERIALS SHALL BE INSTALLED IN ACCORDANCE WITH THE MANUFACTURERS LATEST WRITTEN INSTRUCTIONS AND SPECIFICATIONS
- 27. THE CONTRACTOR SHALL COORDINATE ALL FINISHES AND COLOR SELECTIONS WITH THE OWNER'S REPRESENTATIVES
- 28. ALL FASTENERS INTO PRESSURE TREATED LUMBER ARE TO BE HOT DIPPED GALVANIZED OR STAINLESS STEEL AS RECOMMENDED BY MANUF. OF THE PRESSURE TREATED LUMBER.
- 29. ALL LOAD BEARING WALLS SHALL ALIGN WITH FLOORS ABOVE. SEE STRUCTURAL DRAWING SERIES GENERAL NOTES AND STUD SHEAR WALL PLAN NOTES.

MANAGING THE RISK OF MOLD

- 1. THE CONTRACTOR SHOULD HAVE A PLAN FOR PROTECTING MATERIALS FROM WATER DAMAGE DURING CONSTRUCTION. THE CONTRACTOR SHOULD PAY ATTENTION TO THE WAY IT PROCURES MATERIALS, SCHEDULES THEIR DELIVERY AND THEN STORES THEM, PARTICULARLY ON THE CONSTRUCTION SITE. THE CONTRACTOR MAY, FOR EXAMPLE, ESTABLISH PROCEDURES FOR CHECKING MATERIALS FOR ANY WATER DAMAGE BEFORE ACCEPTING THEIR DELIVERY. THE CONTRACTOR SHOULD ALSO HAVE PROCEDURES FOR KEEPING DRYWALL, CEILING TILES, INSULATION AND OTHER POROUS MATERIALS DRY AND FOR DEALING WITH ANY POROUS MATERIALS THAT DO GET WET. SUCH MATERIALS CANNOT BE PROTECTED FROM AMBIENT MOISTURE BUT, ONCE DELIVERED; THEY CAN AND SHOULD BE PROTECTED FROM OTHER SOURCES OF WATER.
- 2. THE CONTRACTOR SHOULD NOT PERMIT NEW OR ADDITIONAL WORK TO COVER OR ENCLOSE ANY FIREPROOFING, INSULATION OR OTHER POROUS MATERIALS THAT ARE CLEARLY WET.
- 3. THE CONTRACTOR SHOULD ALSO HAVE SOME KIND OF PROTOCOL FOR DEALING WITH ANY LARGE AND UNEXPECTED WATER INTRUSION INTO ANY COMPLETED PORTION OF THE BUILDING. SUCH A PROTOCOL MUST BE PRESENTED TO THE CLIENT PRIOR TO THE START OF ANY WORK.
- 4. ALL MASONRY SYSTEMS ARE TO HAVE WEEPS THAT WILL ALLOW ANY MOISTURE THAT MIGRATES TO THE INSIDE OF THE MASONRY WALL TO DRAIN OUT.
- 5. SITE CONDITIONS: THE CONSTRUCTION SITE AND STAGING AREAS MUST BE DESIGNED SO THAT ANY WATER OR RAIN WATER MUST FLOW AWAY FROM THE BUILDING AND CONSTRUCTION MATERIAL. THE CIVIL PLANS MUST DRAIN MOISTURE AND WATER AWAY FROM THE BUILDING AFTER THE CONTRACTOR COMPLETES IT. IMPORTANT DETAILS INCLUDE LANDSCAPING, BACKFILL AND SOIL COMPACTION. ALONG WITH ANY INDUCED MOISTURE (FROM IRRIGATION, OR BROKEN WATER OR SEWER PIPES, OR OTHER SOURCES), THIS NATURALLY OCCURRING MOISTURE NEEDS TO HAVE A WAY TO DRAIN OFF. IF THIS IS NOT EVIDENT ON THE PLANS, THE GC MUST NOTIFY THE ARCHITECT OR CIVIL ENGINEER IMMEDIATELY
- 6. THE CONTRACTOR MUST NOT LOAD OR INSTALL ANY DRYWALL OR OTHER POROUS OR ORGANIC MATERIALS IN THE BUILDING BEFORE CONSTRUCTION HAS REACHED THE "CONTROLLED" PHASE;
- 7. PROCEDURES FOR OPERATING AND MAINTAINING THE HVAC SYSTEM IN ACCORDANCE WITH THE CURRENT GUIDELINES OF THE AMERICAN SOCIETY OF HEATING, REFRIGERATING AND AIR CONDITIONING ENGINEERS, INC. (ASHRAE), INCLUDING PROCEDURES FOR MAINTAINING THE SYSTEM

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| General Building Notes | | | |
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BUILDING CODES AND SPECIAL LAND USE

MICHIGAN BUILDING CODE(MBC) AND THE MICHIGAN REHABILITATION CODE FOR EXISTING BUILDINGS 2015 WERE REVIEWED FOR THIS BUILDING.

THE BUILDING IS CONSTRUCTED AS A MASONRY NONCOMBUSTIBLE EXTERIOR WALL CONSTRUCTION WITH UNPROTECTED (WOOD) AND COMBUSTIBLE INTERIOR CONSTRUCTION - TYPE 5 B.

THE PROPOSED USES WERE APPROVED ON OCTOBER 22, 2015 AT A SPECIAL LAND USE HEARING BEFORE THE CITY OF GRAND RAPIDS PLANNING COMMISSION. THE SLU ALLOWS THE FIRST FLOOR TO BE USED AS A HOUSE OF WORSHIP NOT TO EXCEED THE MAXIMUM OF 50 OCCUPANTS (PS-SLU-2015-0082)

THE FIRST FLOOR WORSHIP IS CLASSIFIED AS ASSEMBLY GROUP A-3 (MBC 303.4) THE PROPOSED BOOKSTORE ON THE FIRST FLOOR IS CLASSIFIED AS MERCANTILE GROUP M (MBC 309.1) THE FOUR ONE BEDROOM APARTMENTS ON THE SECOND FLOOR ARE CLASSIFIED AS RESIDENTIAL GROUP R-2 (MBC 310.4)

THE USE SEPARATION REQUIRED BETWEEN GROUP A-3 ON THE FIRST FLOOR AND GROUP R-2 ON THE SECOND FLOOR IS ONE HOUR FIRE RATED CONSTRUCTION. ONE HOUR FIRE RATED CONSTRUCTION IS ALSO NEEDED ON THE STAIRWELL BETWEEN THE SECOND AND FIRST FLOOR. THERE IS NO FIRE SEPARATION M OCCUPANCY AND THE A-3 OCCUPANCY ON THE FIRST FLOOR. THE BASEMENT IS USED FOR STORAGE AND UTILITES AND THERE IS NO FIRE SEPARATION FROM THE FIRST FLOOR.

FOR THE FIRST FLOOR OCCUPANCY OF A-3, THE OCCUPANT LOAD IS 50. ACCORDING TO MBC TABLE 1006.2.1, TWO EXITS ARE REQUIRED. DUE TO THE SIZE OF THE BUILDING THE TRAVEL DISTANCES BETWEEN THE EXITS IS A NON ISSUE. HOWEVER, NEITHER OF THE STOREFRONT'S EXITS MEET EGRESS OR ACCESSIBILITY REQUIREMENT AND MUST BE REPLACED WITH APPROPRIATELY LABELED DOORS, SWINGS, AND PANIC HARDWARE. (MBC SECTION 1010). THE MEN'S ROOM, UNISEX ROOM, AND WATER FOUNTAIN MEET ACCESSIBILITY REQUIREMENTS.

THE MEN'S AND WOMEN'S WORSHIP IS CONSIDERED AN ASSEMBLY AREA OCCUPANCY WITH A UNIFORMLY DISTRIBUTED LIVE LOAD (UDLL) OF 100 POUNDS PER SQUARE FOOT (PSF). THE BOOKSTORE IS CONSIDERED A LIBRARY STACK OCCUPANCY WITH A UDLL OF 150 PSF. A 2 X 6 STUD WALL IS PROVIDED IN THE BASEMENT TO SUPPORT THE FIRST FLOOR LIVE LOAD OF THESE OCCUPANCIES. THESE STRUCTURAL SOLUTIONS WERE COMPLETED IN CONSULTATION WITH HOFFMAN CONSULTANTS, LLC, STRUCTURAL CONSULTANTS.

THE CURRENT MECHANICAL AND PLUMBING CODES ARE THE 2015 MICHIGAN MECHANICAL CODE AND MICHIGAN PLUMBING CODE AS CURRENTLY IN EFFECT. THE CURRENT ELECTRICAL CODE IS THE CURRENT NATIONAL ELECTRIC CODE OF 2014 AS ADAPTED BY THE STATE OF MICHIGAN.

SCOPE OF WORK

PHASE 2.1 - BASEMENT AND 1ST FLOOR PLAN (SOUTHERN PORTION)

DEMOLITION OF EXISTING WALLS AND CEILING, SOUTH PORTION OF BUILDING (BY OWNER) UNLESS OTHERWISE NOTED ON DRAWINGS.

PROJECT AREA IS ANY ITEMS SOUTH OF THE CENTER OF THE WALL THAT RUNS EAST TO WEST IN THE BUILDING WITH THESE ADDITIONAL STIPULATIONS:

ROUGH IN PLUMBING FOR MEN'S ROOM 4

COMPLETE THE ONE HOUR FIRE RATING FOR THE ENCLOSURE OF THE STAIR FROM THE FIRST TO SECOND FLOOR.

(BOTH SIDES OF THE STAIRS).

REPAIR OR REPLACE ANY BROKEN WINDOWS OR GLASS IN THE BUILDING.

ANY EXISTING DAMAGED WALLS, REPAIR AND PAINT

WHEN PHASE 2.1 IS COMPLETE, THE HEATING, COOLING, ELECTRICAL, PLUMBING (WATER AND SEWER) SHALL BE FULLY OPERATIONAL FOR THE

FIRST FLOOR AND BASEMENT ON THE SOUTH HALF OF THE BUILDING.

PLUMBING UPDATES TO THE FLOOR OF SECOND FLOOR PLAN SHALL BE INCLUDED IN PHASE 2.1

PHASE 2.2 - BASEMENT AND FIRST FLOOR PLAN (NORTHERN PORTION) DEMOLITION OF EXISTING WALLS AND DROPPED CEILING, NORTH PORTION OF BUILDING (BY OWNER) UNLESS OTHERWISE NOTED ON THE DRAWINGS.

PROJECT AREA IS ANY ITEMS NORTH OF THE CENTER OF THE WALL THAT RUNS EAST TO WEST IN THE BUILDING WITH THESE ADDITIONAL STIPULATIONS:

COMPLETE EVERYTHING IN THE MEN'S ROOM (PLUMBING FIXTURES AND ACCESSORIES.)

ANY EXISTING DAMAGED WALLS, REPAIR AND PAINT

INSTALL AND CONNECT HEATING AND COOLING, ELECTRICAL, PLUMBING, (WATER AND SEWER) TO MAKE IT FULLY OPERATIONAL ON THE FIRST FLOOR AND BASEMENT.

PLUMBING UPDATES TO THE FLOOR OF THE SECOND FLOOR SHALL BE INCLUDED IN PHASE 2.2

INSTALL DOOR 16

ANY ITEM MISSED ON PHASE 2.1 AND SHOWN ON THE DRAWINGS, NEEDS TO BE COMPLETED IN PHASE 2.2

PHASE 3 - CHANGES TO THE SECOND FLOOR , NOT INCLUDED IN THESE DOCUMENTS

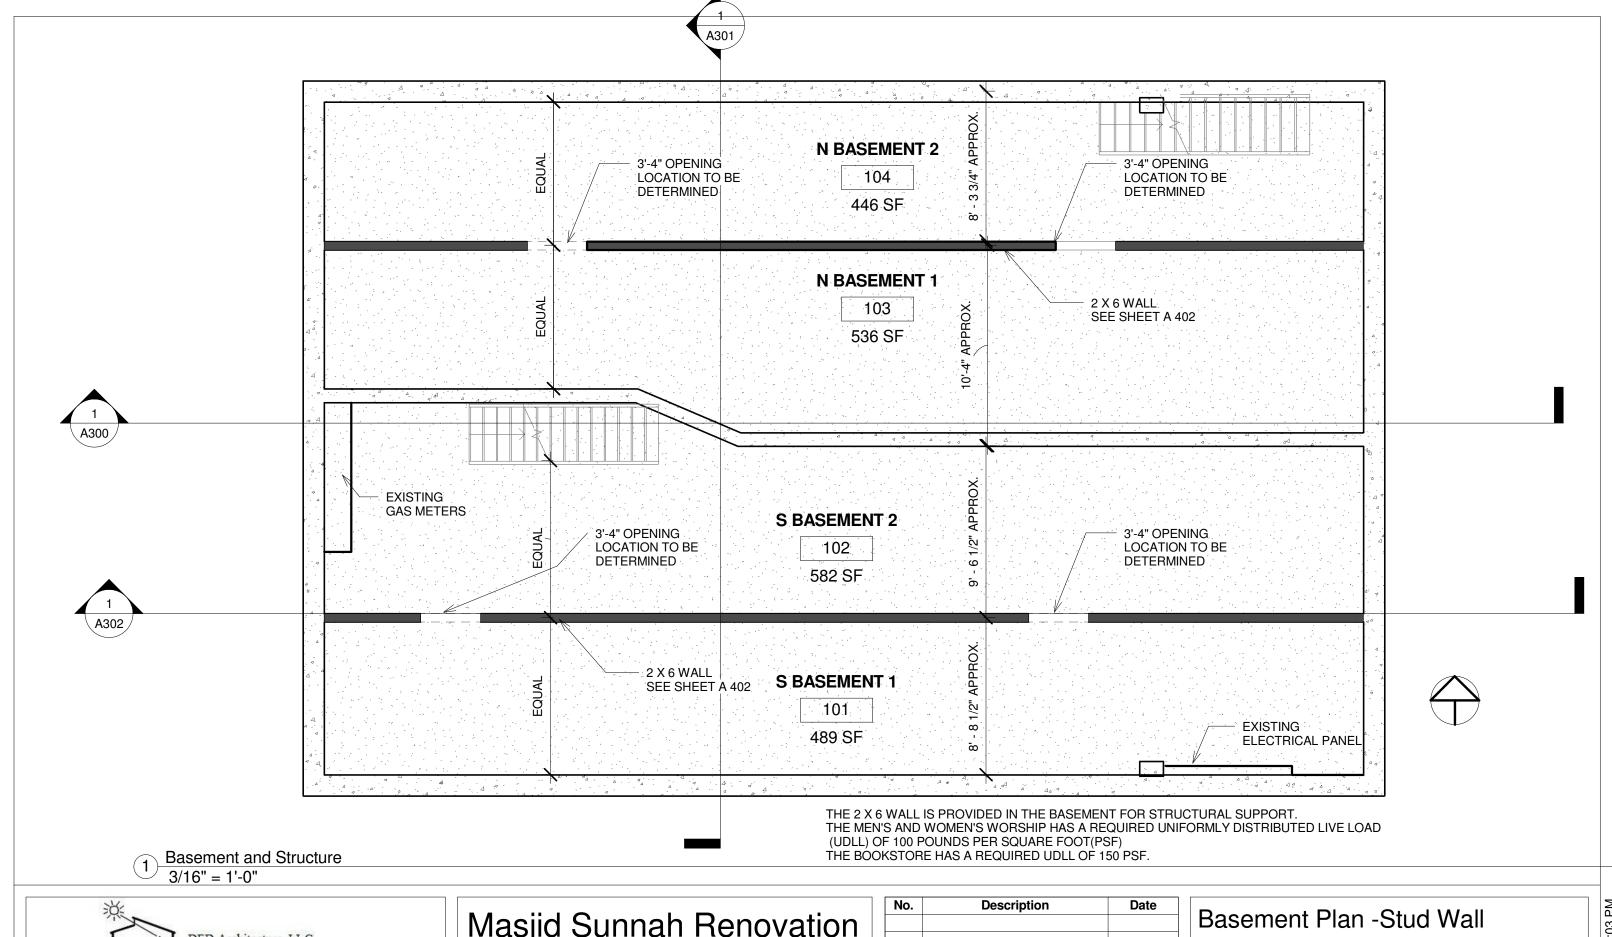


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| Bldg Codes/Phase Descriptions | | | |
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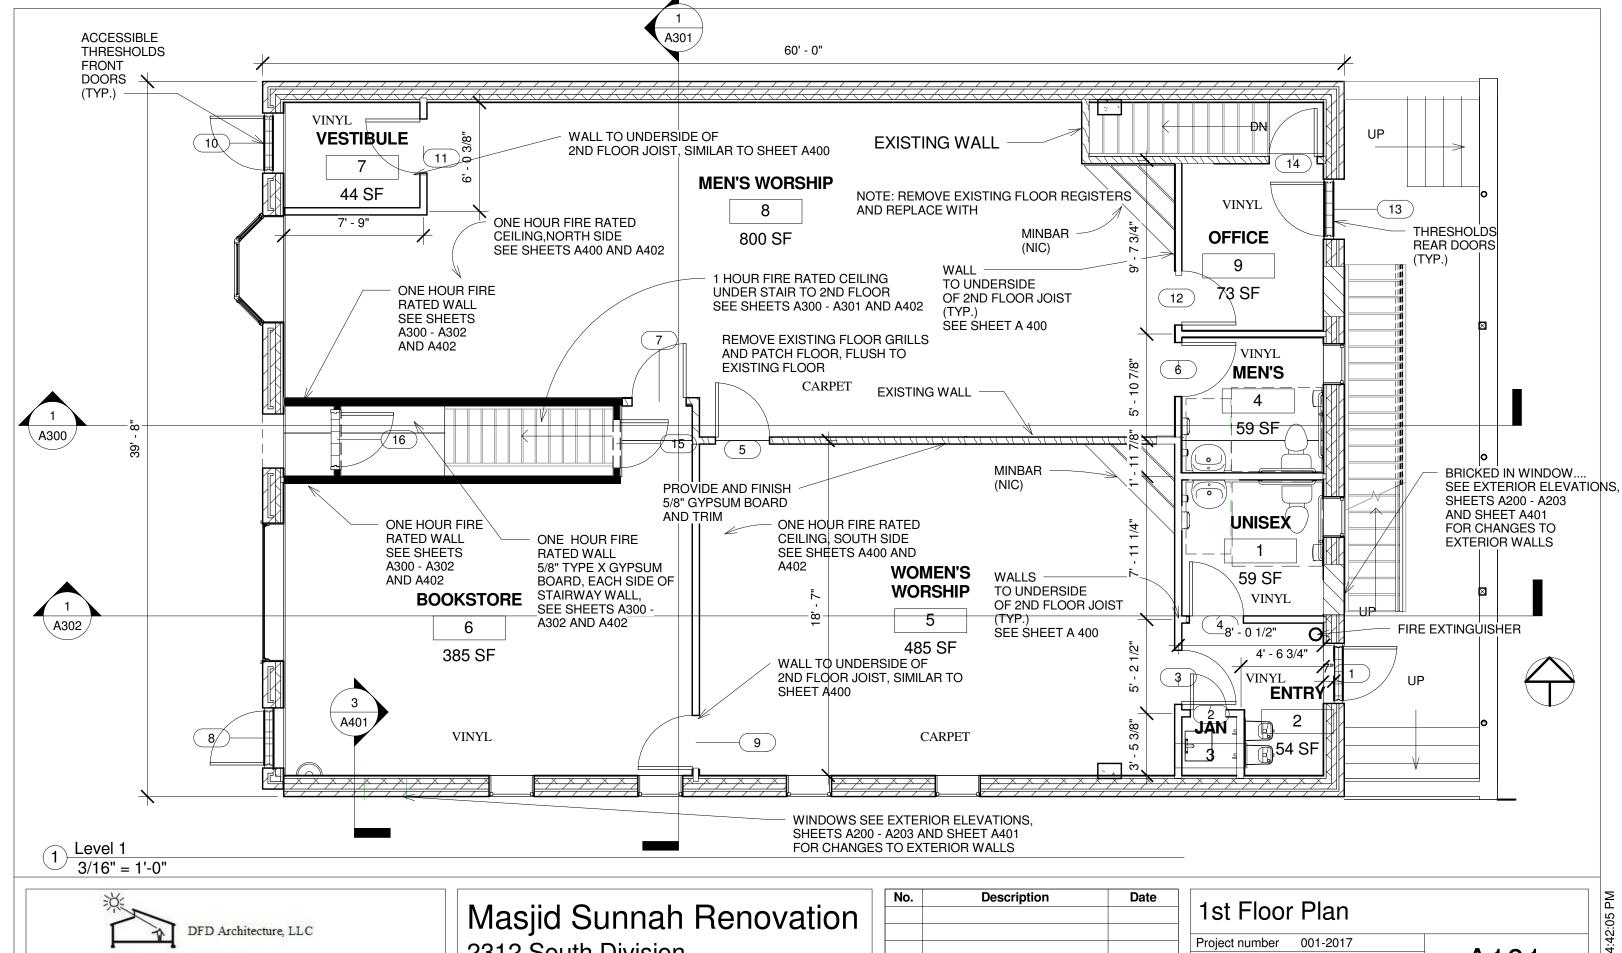




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| Basement Plan -Stud Wall | | | |
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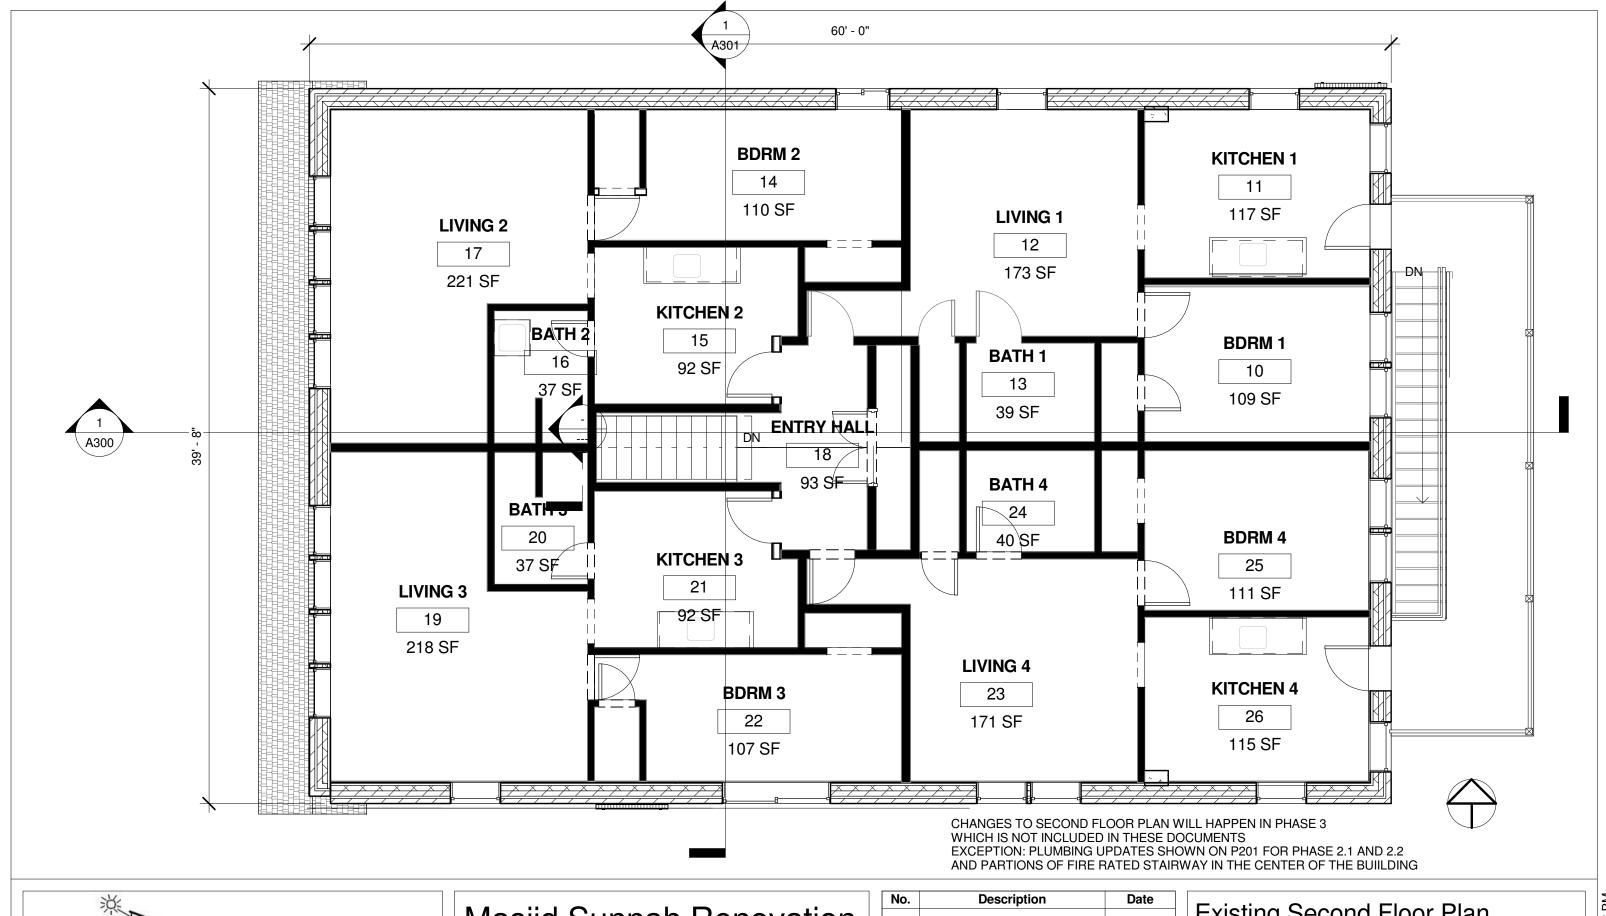


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| 1st Floor | Plan | | 4.42.05 DM |
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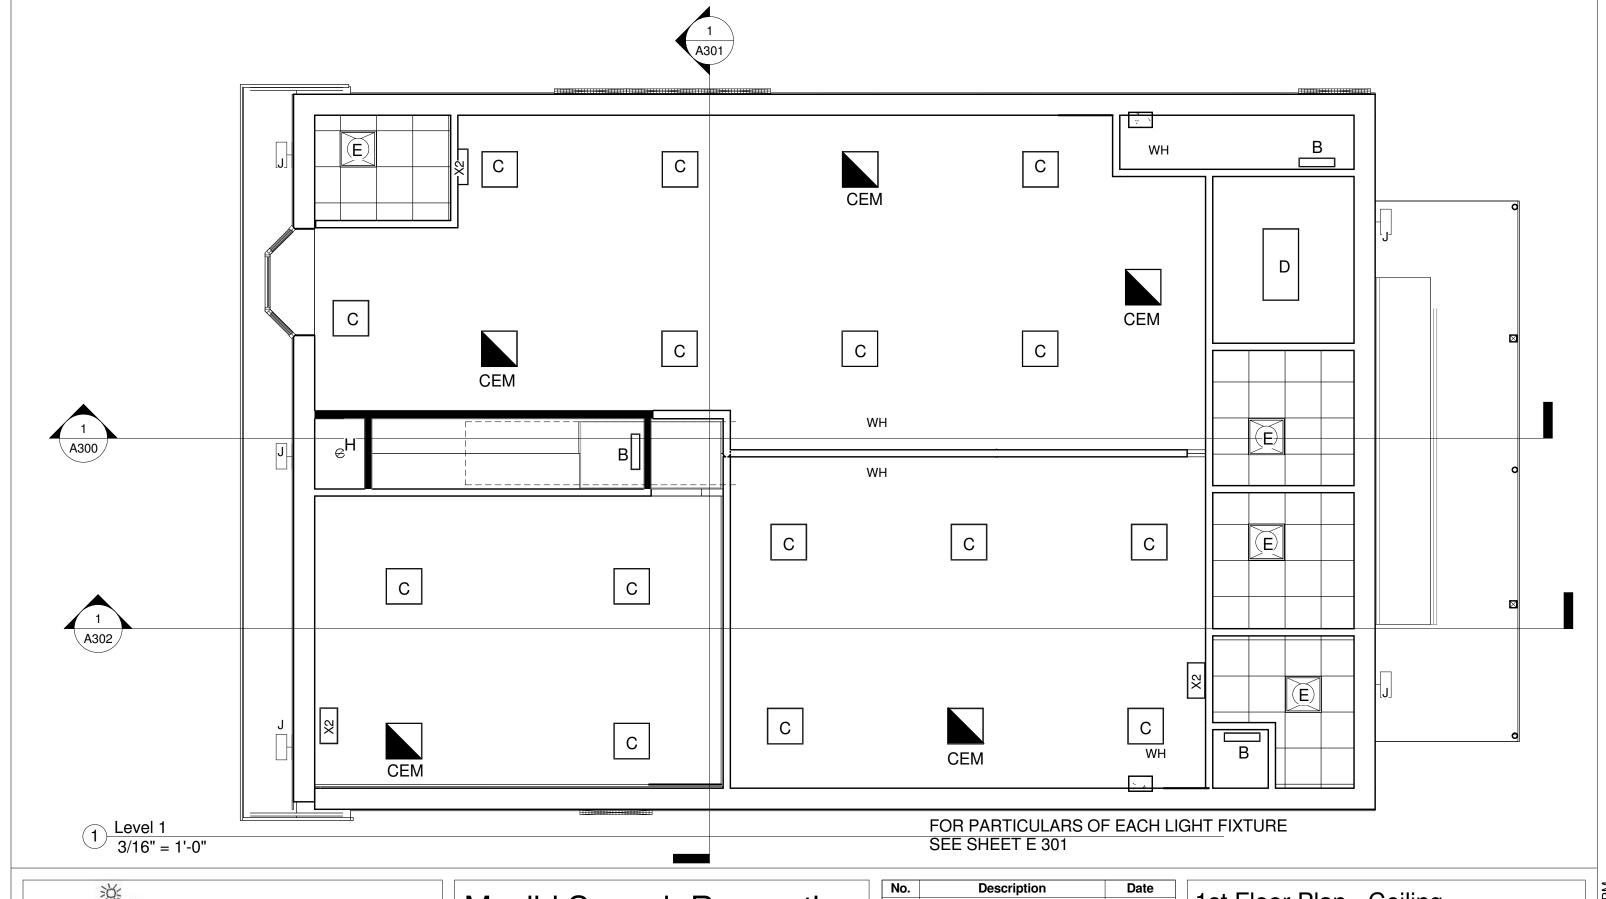




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| Existing Second Floor Plan | | 70.00 | |
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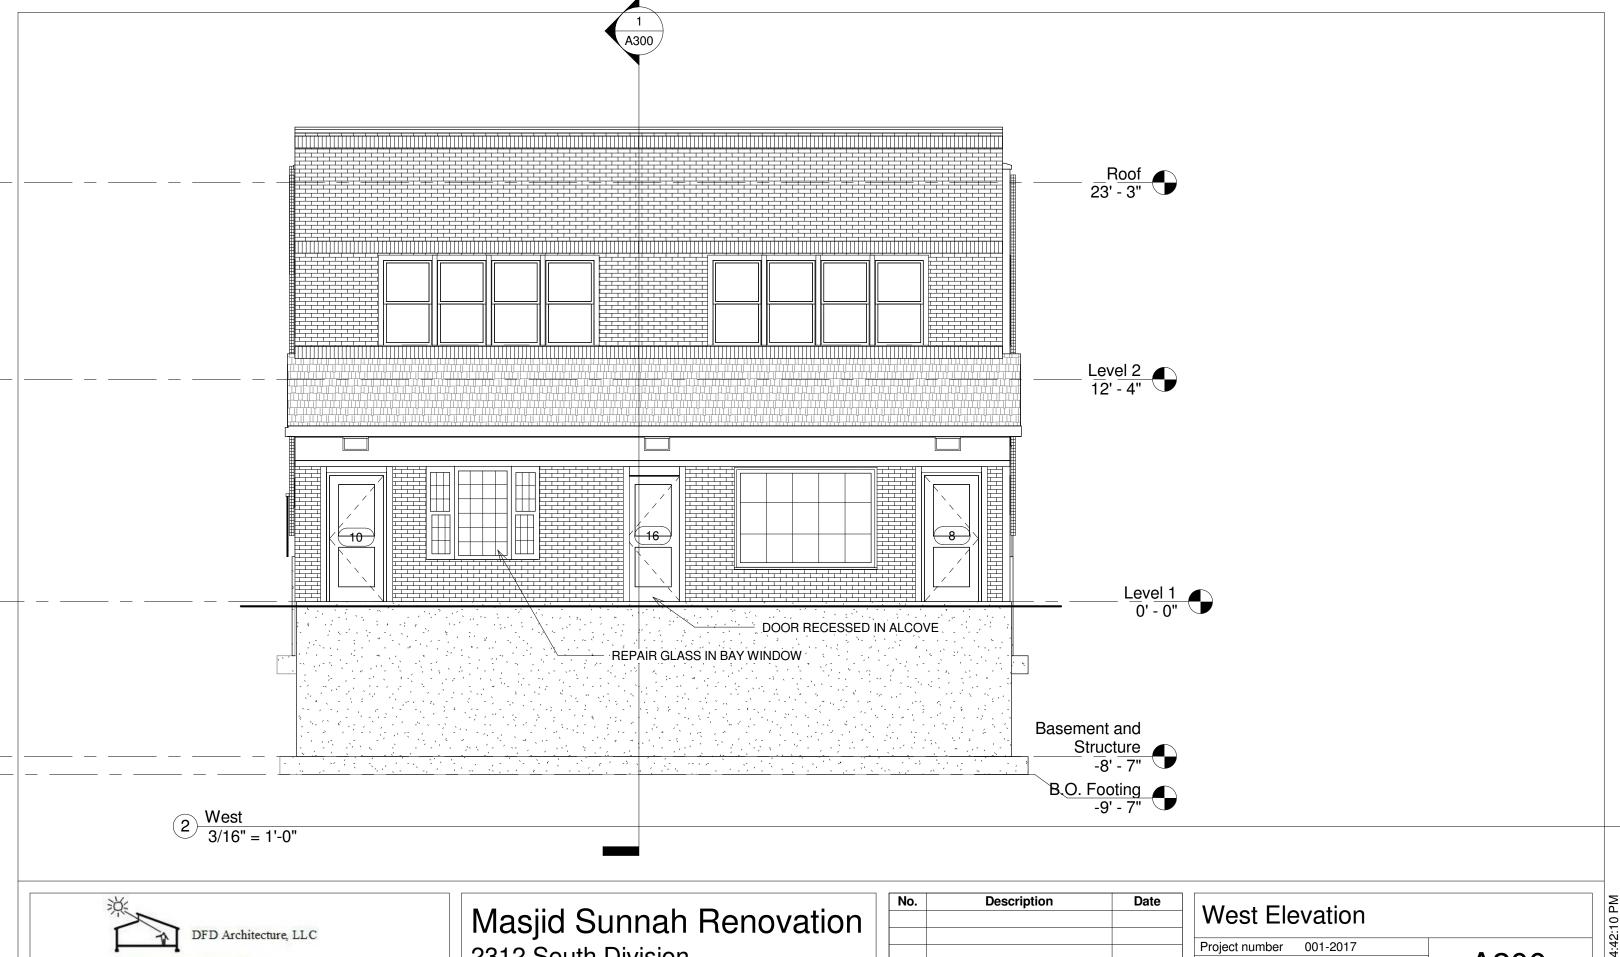




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| 1st Floor Plan - Ceiling | | | _ |
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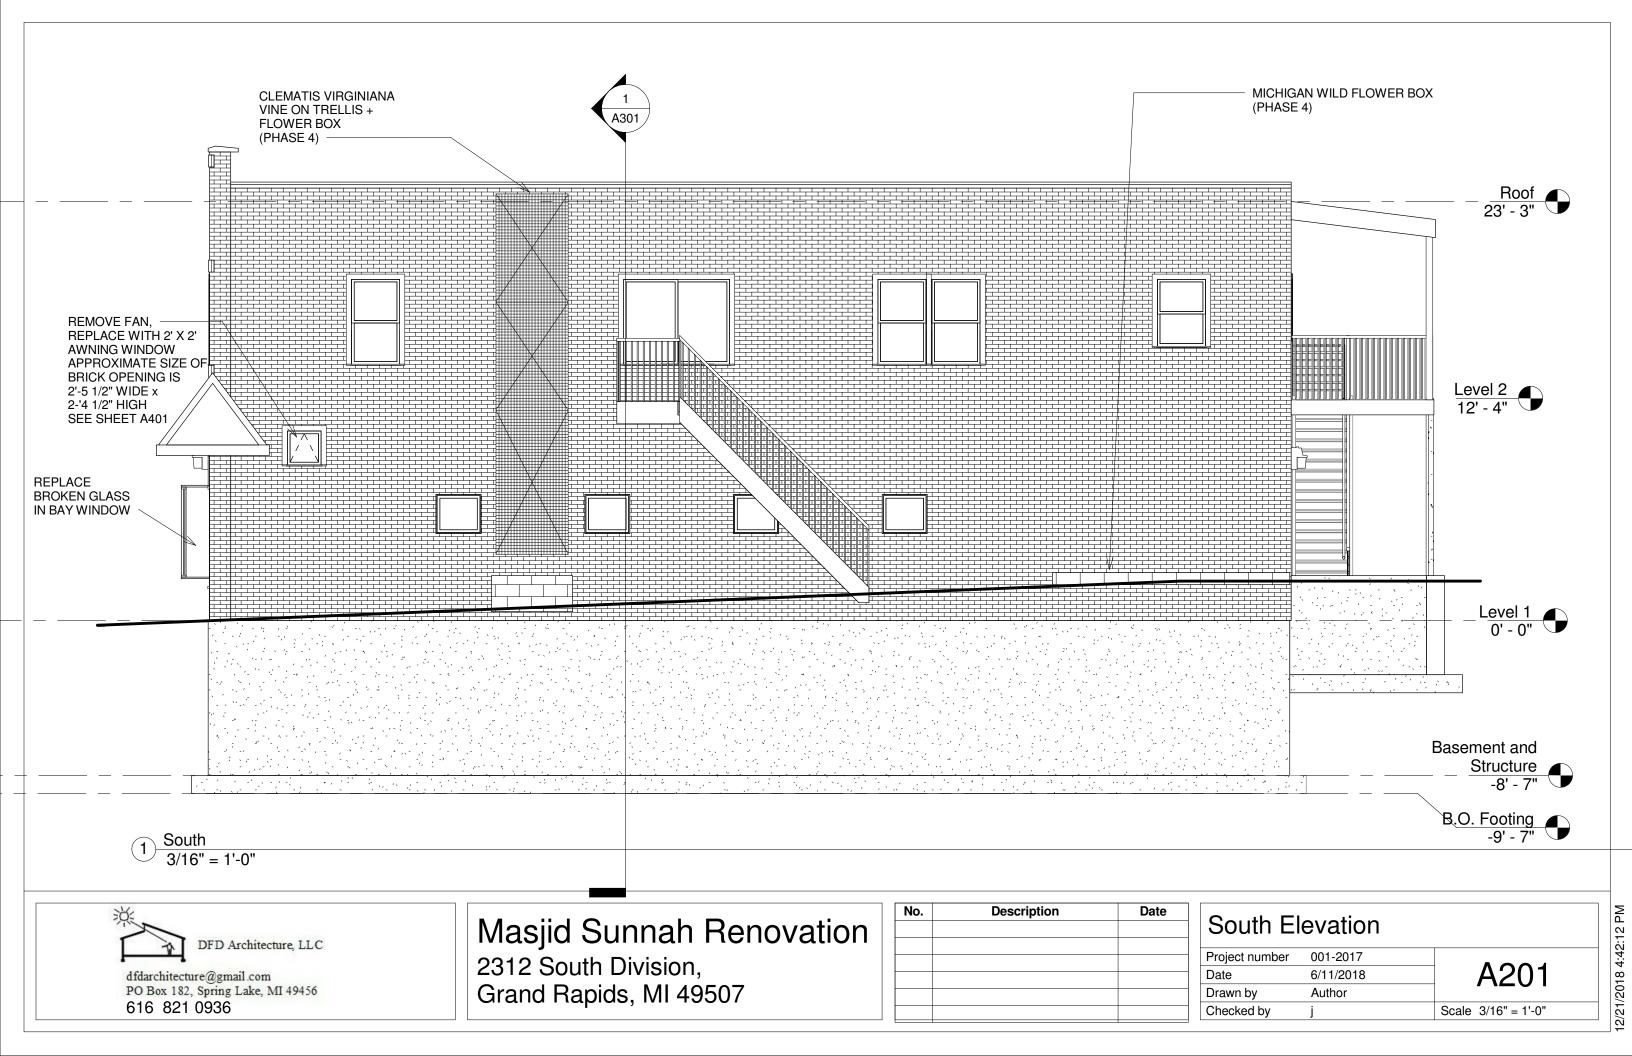


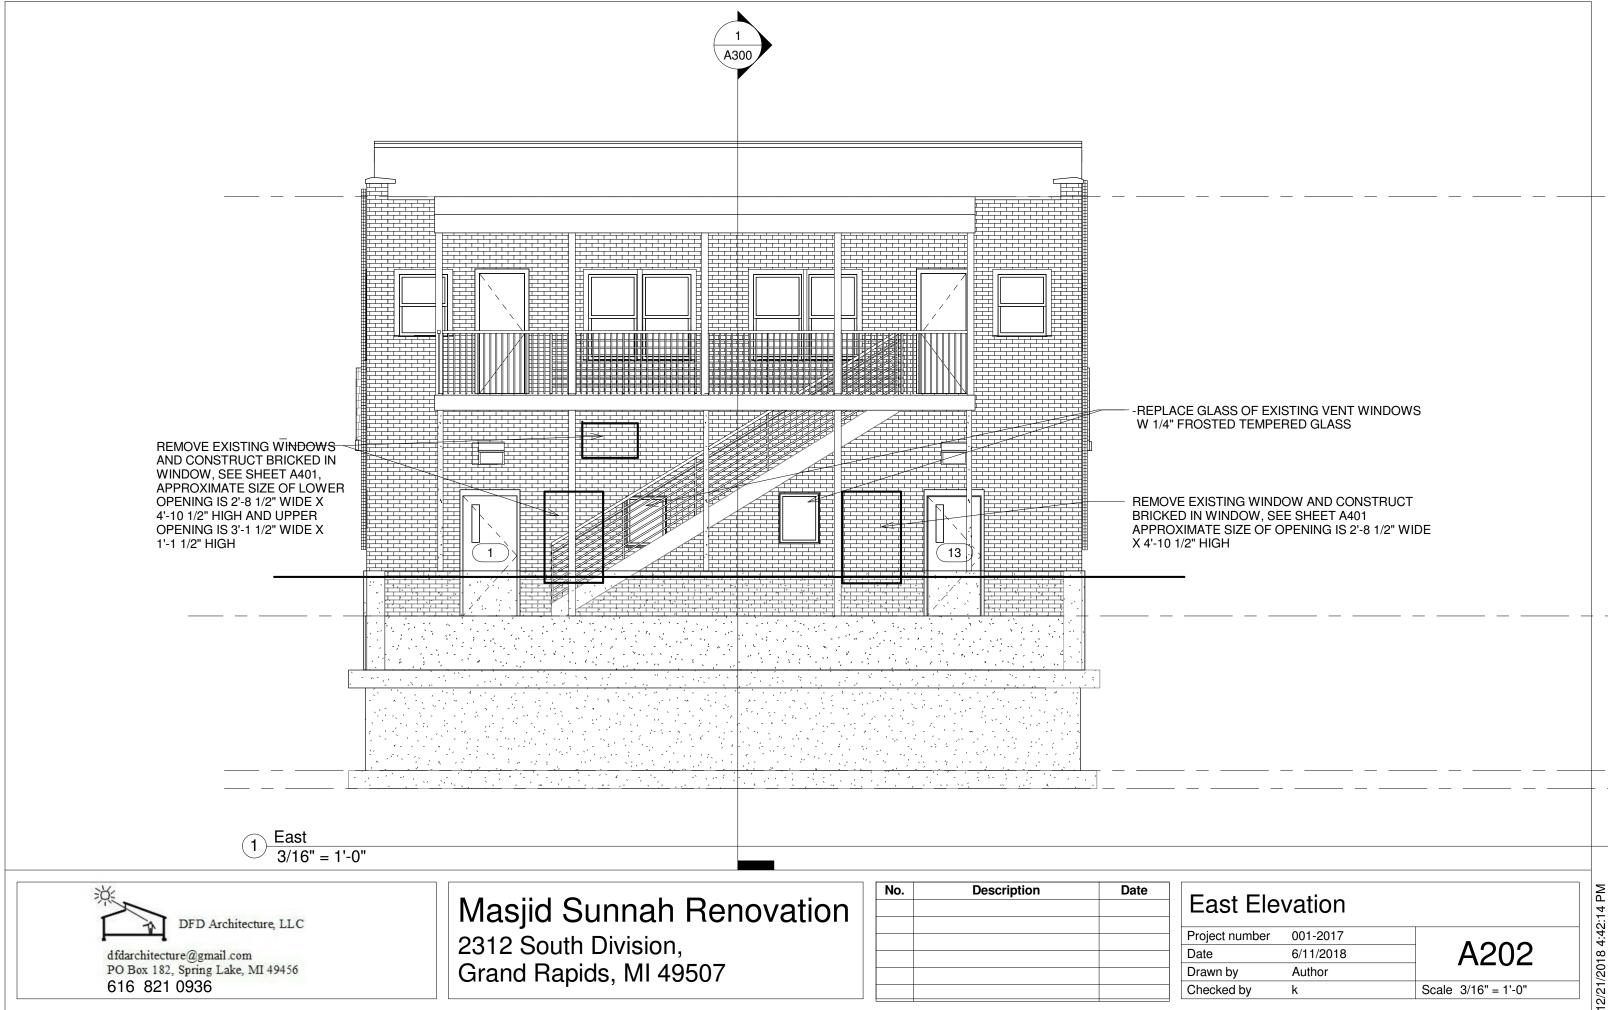
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| West Ele | evation | | 6 |
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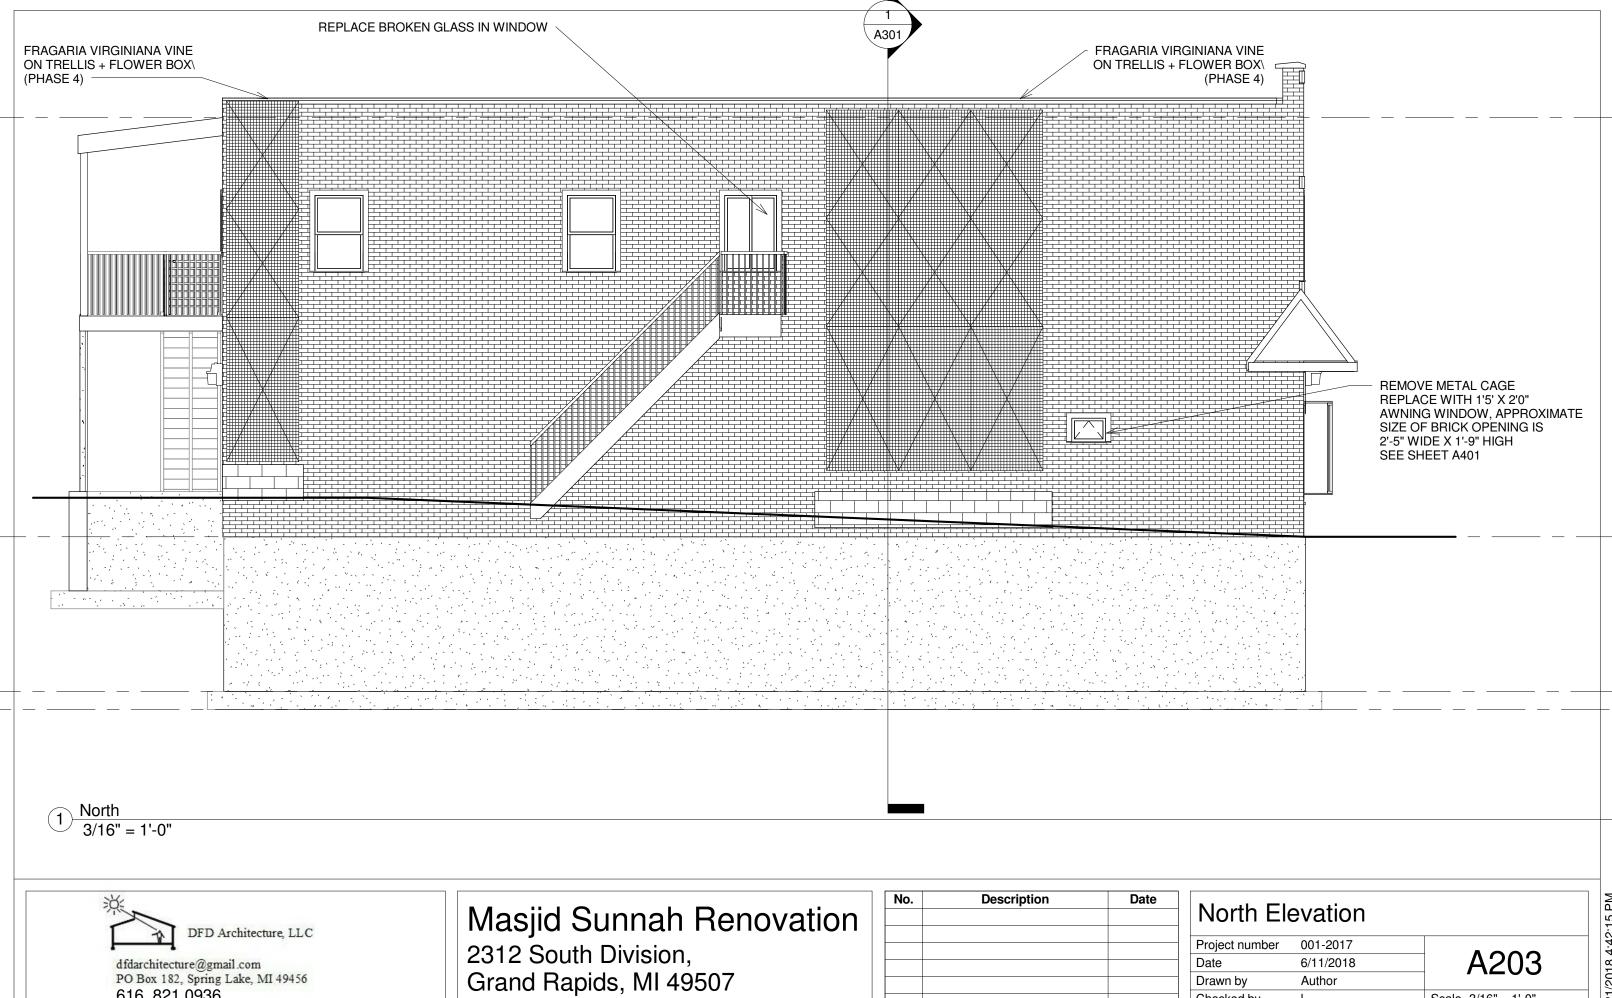




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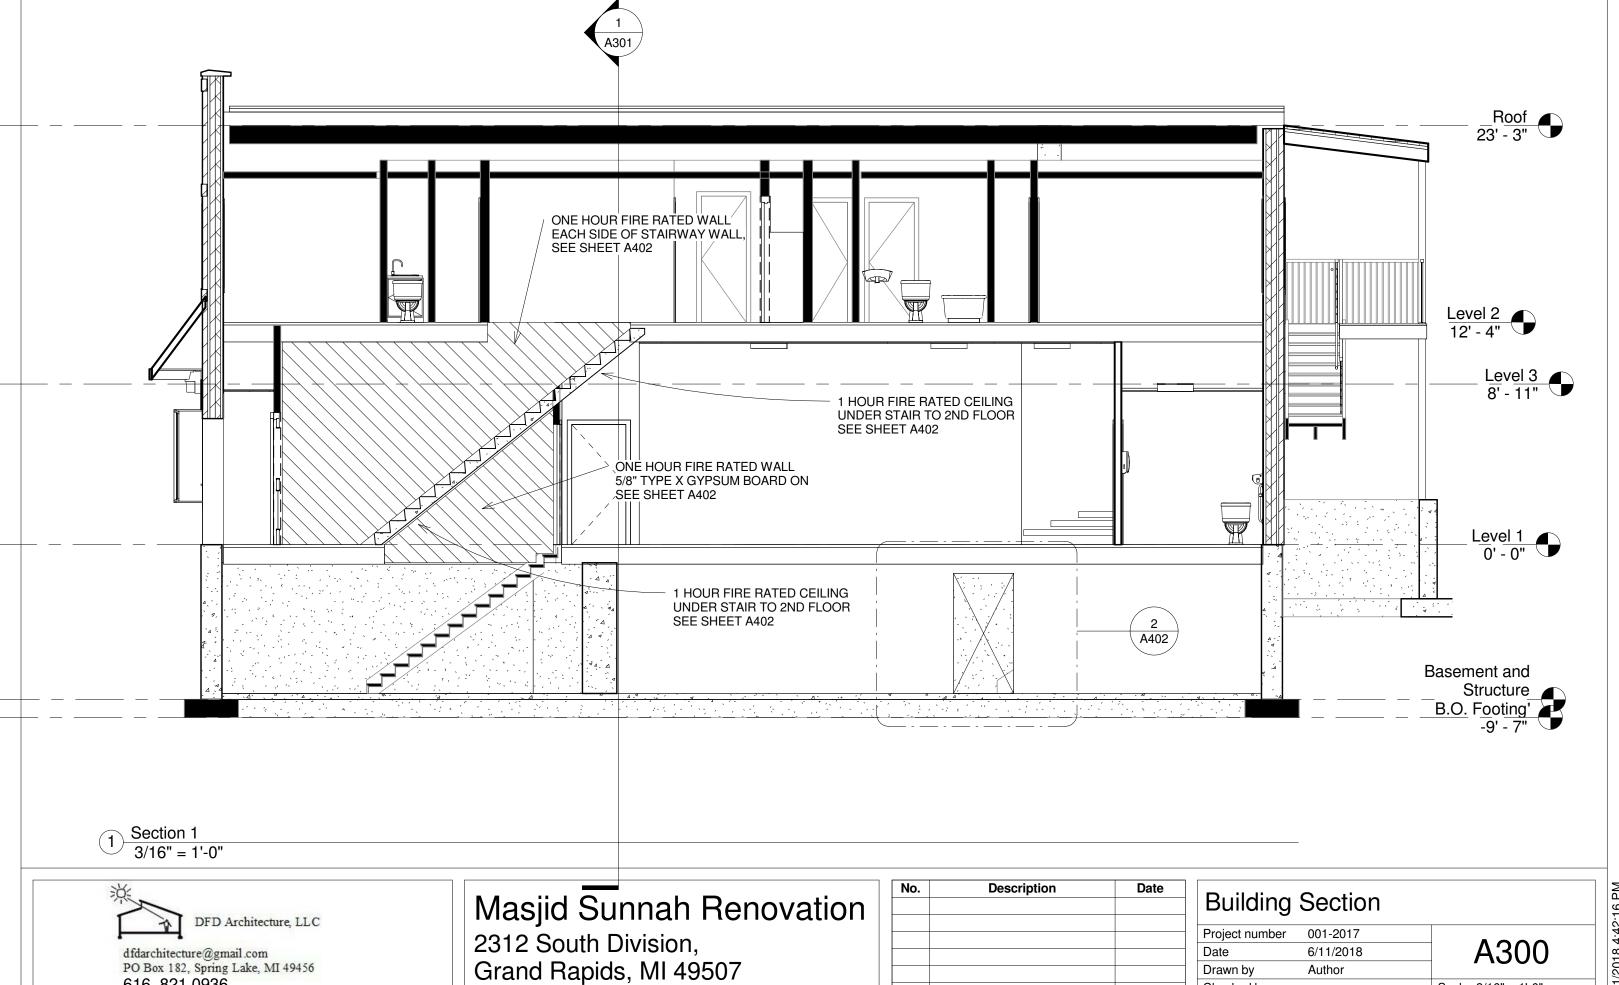
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| East Elevation | | |
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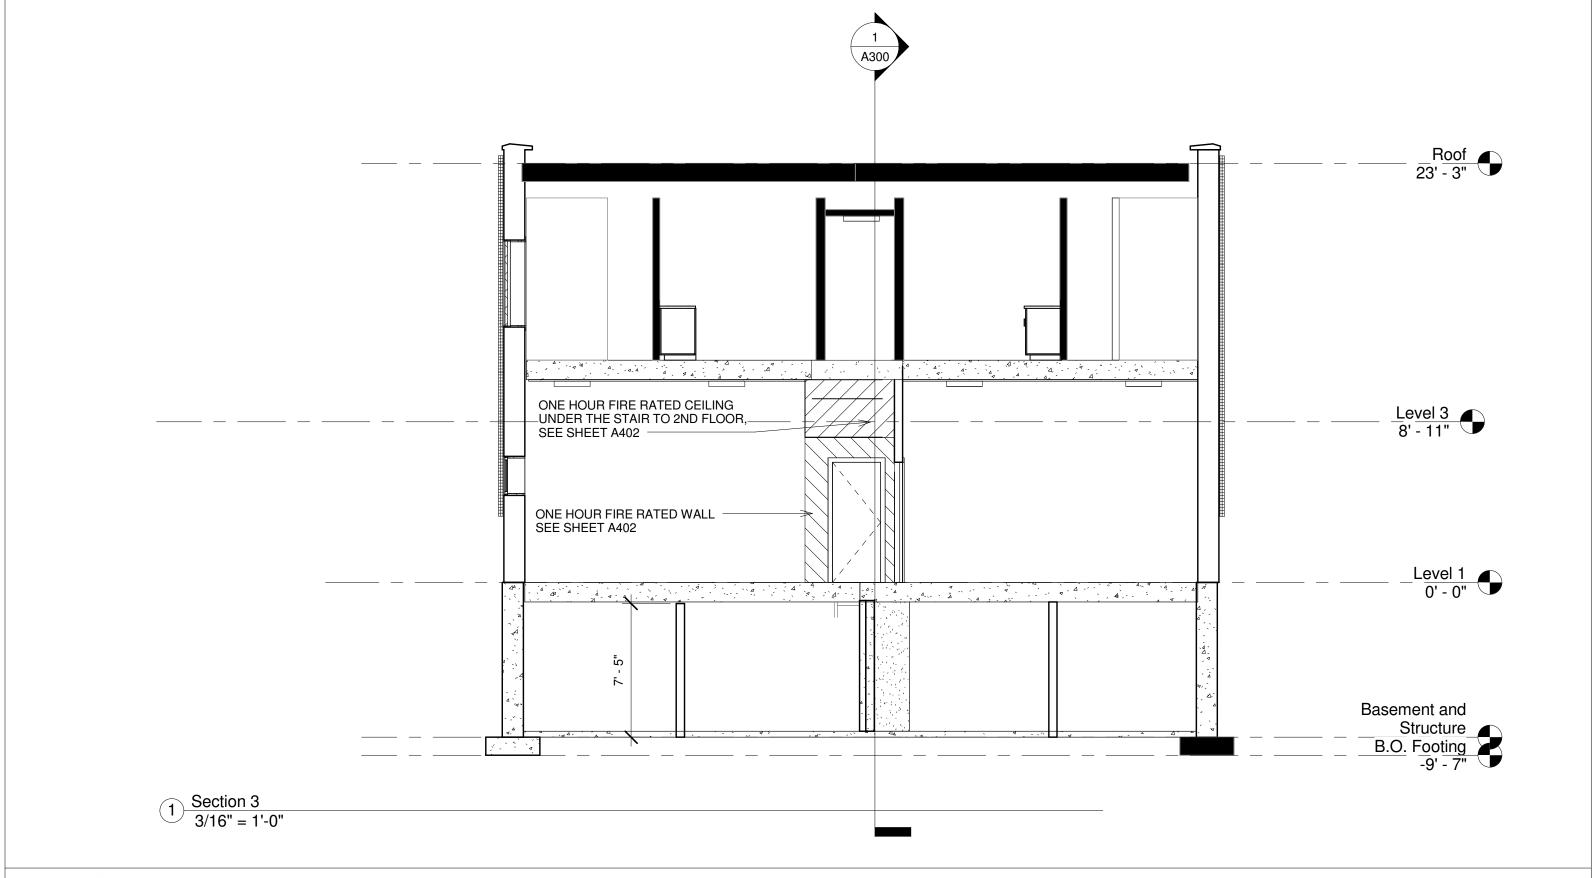


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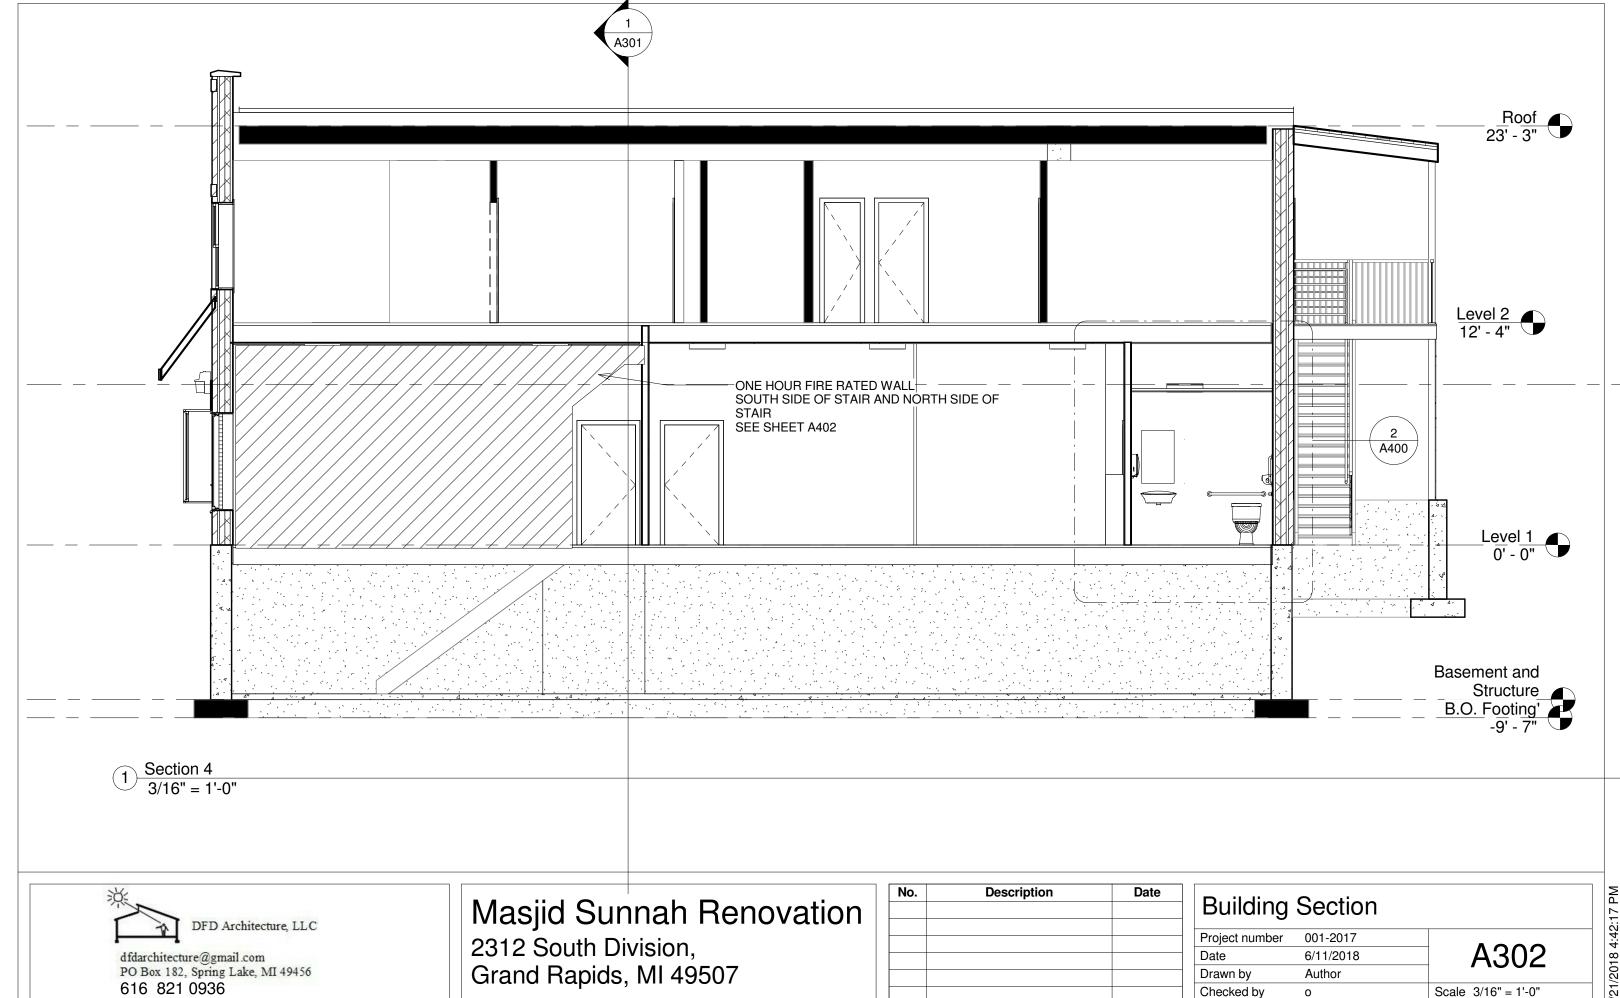
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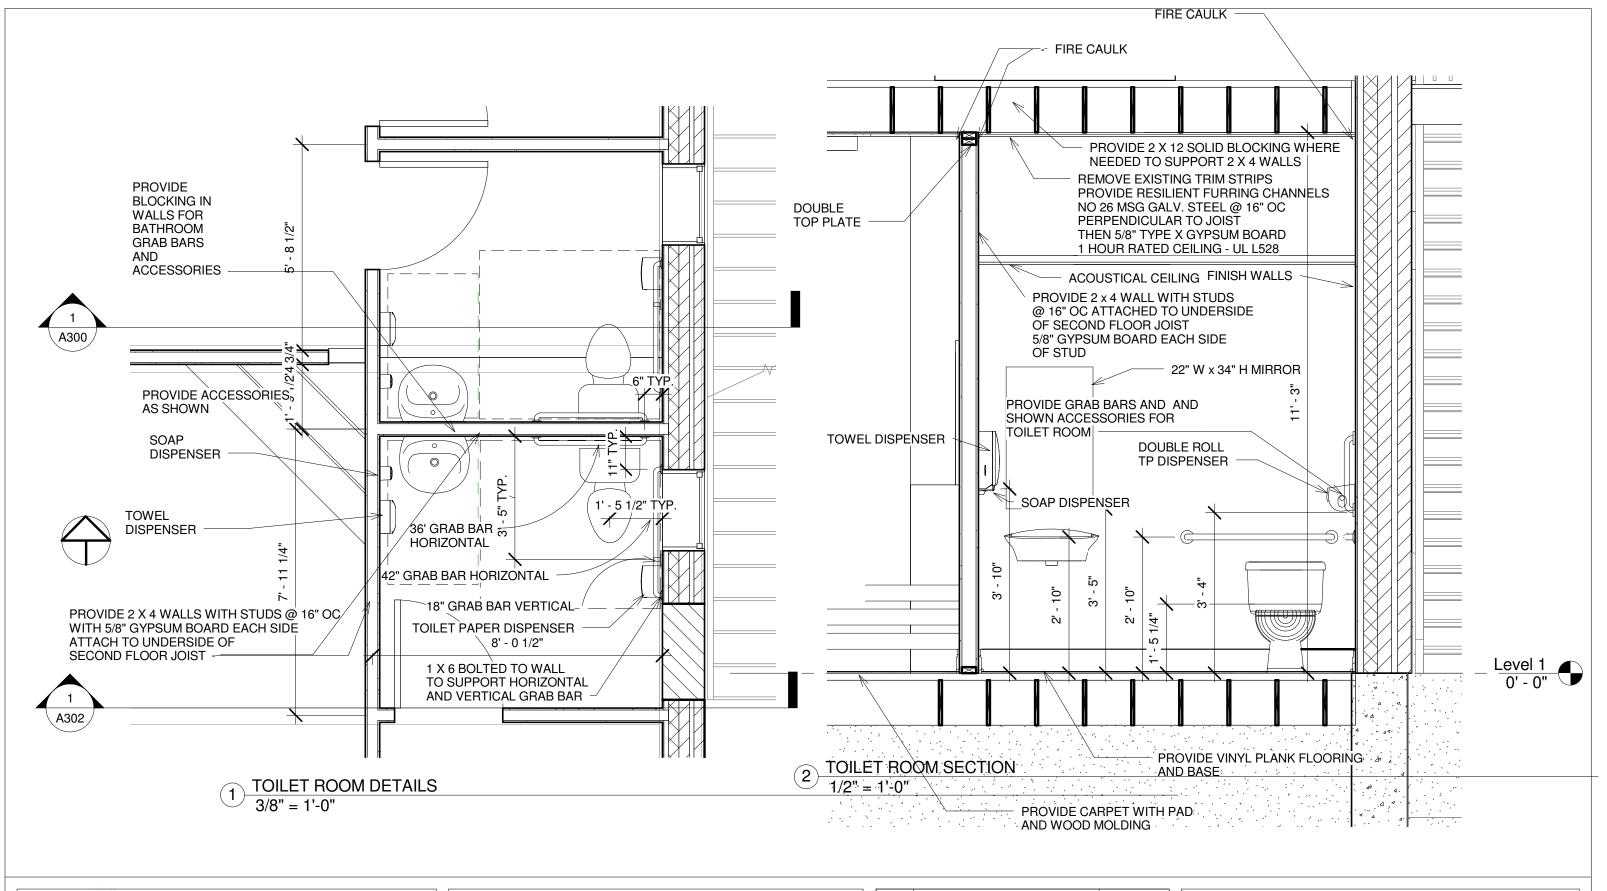
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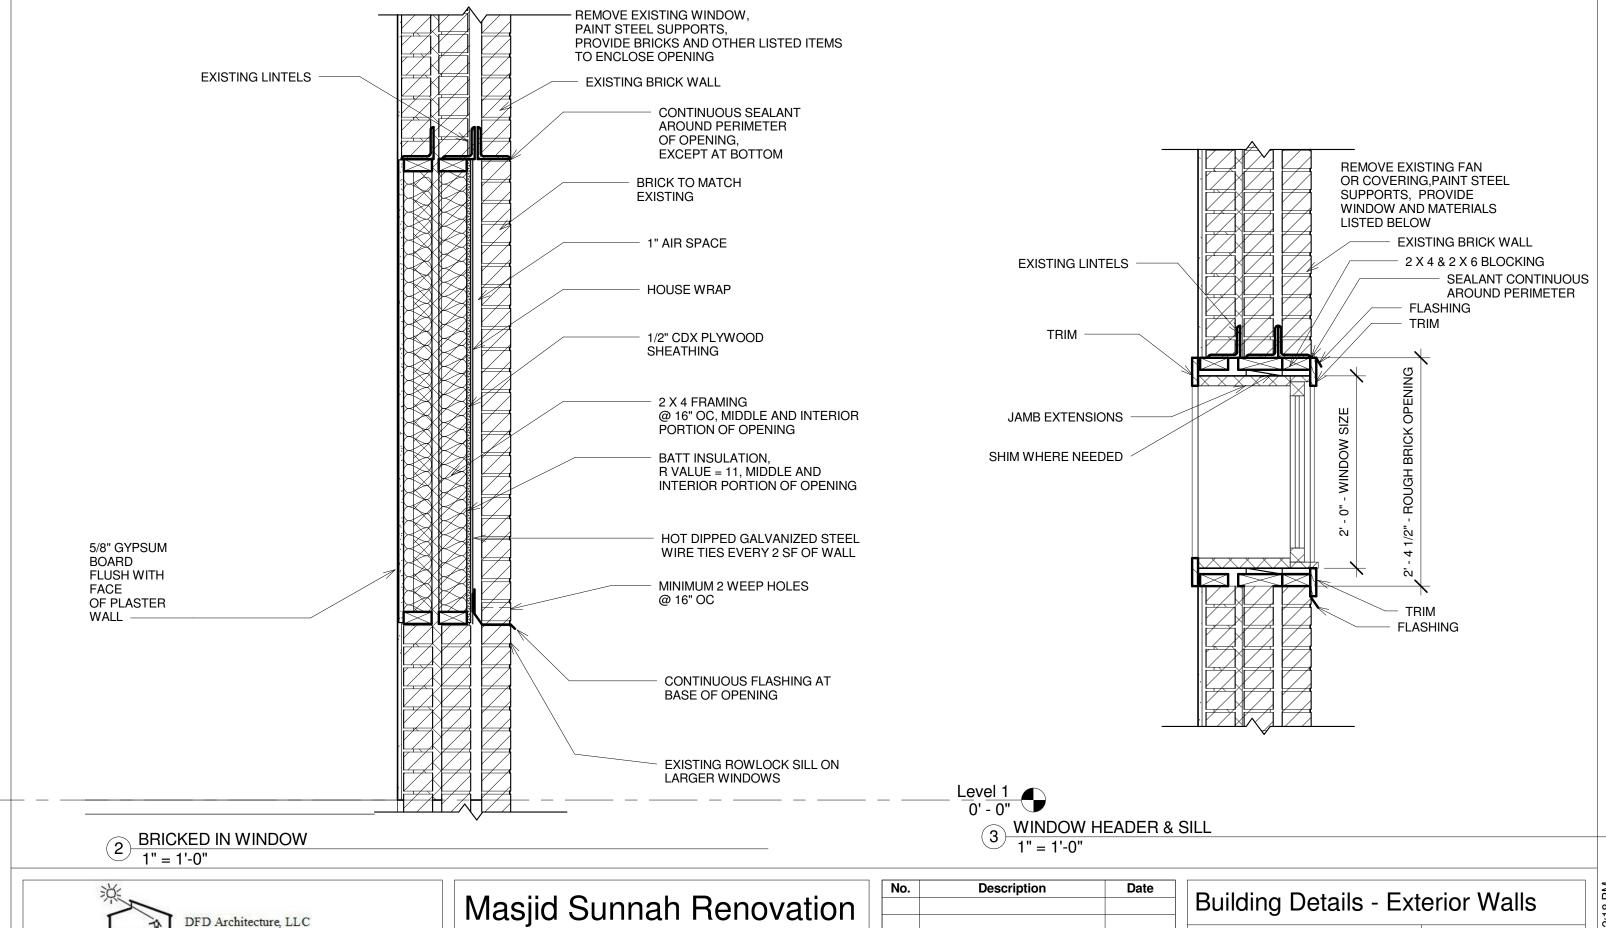


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Wall Sections and Detailed Plans

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| roject number | 001-2017 | A 400 |
| ate | 6/11/2018 | A400 |
| rawn by | Author | , |
| hecked by | р | Scale As indicated |
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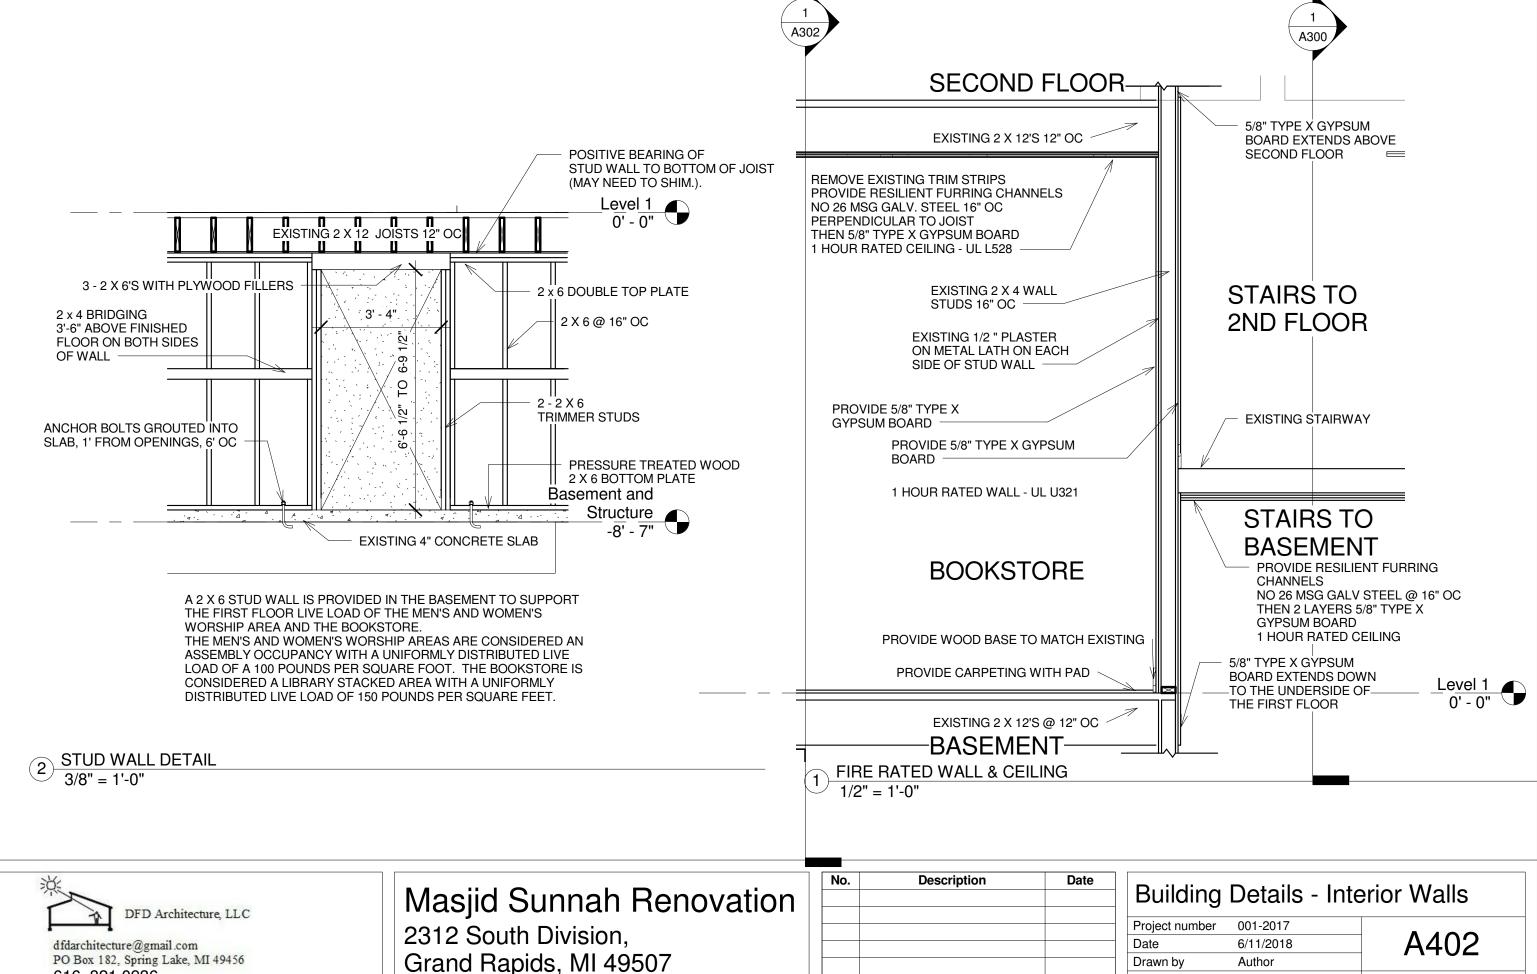


DFD Architecture, LLC

dfdarchitecture@gmail.com
PO Box 182, Spring Lake, MI 49456
616 821 0936

| | No. | Description | Date |
|--|-----|-------------|------|
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| Building | Details - Ext | erior Walls | 4.42.48 DA |
|----------------|---------------|------------------|------------|
| Project number | 001-2017 | | 1. |
| Date | 6/11/2018 | A401 | |
| Orawn by | Author | , | OC/ |
| Checked by | q | Scale 1" = 1'-0" | 0/04/0018 |
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Scale As indicated

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| | | | | | | | Door S | Schedule | | | | | |
|--------|------------|---------|---------|-------------|----------|---------|-------------|--------------------------------|------|----------|---------|--------|--|
| Door | | | | Door | | | | | | Fram | e | Frame | |
| Number | Door Types | Width | Height | Thickness | Material | Finish | Fire Rating | Hardware | Туре | Material | Finish | Header | Comments |
| 1 | В | 3' - 0" | 6' - 8" | 0' - 1 3/4" | STEEL | PAINTED | NO | KEYED EXT. PANIC | 2 | НМ | PAINTED | A501-2 | INSUL., WSTRIP, THRESHOLD, CLOSER |
| 2 | С | 2' - 0" | 6' - 8" | 0' - 2" | WOOD | PAINTED | NO | KEYED DOOR | 4 | WOOD | PAINTED | A501-4 | |
| 3 | С | 3' - 0" | 6' - 8" | 0' - 2" | WOOD | PAINTED | NO | PUSH/PULL HDWR | 4 | WOOD | PAINTED | A501-4 | |
| 4 | С | 3' - 0" | 6' - 8" | 0' - 2" | WOOD | PAINTED | NO | PUSH/PULL HDWR-PRIVACY LOCK | 4 | WOOD | PAINTED | A501-4 | |
| 5 | С | 3' - 0" | 6' - 8" | 0' - 2" | WOOD | PAINTED | NO | PUSH/PULL HDWR | 4 | WOOD | PAINTED | A501-4 | |
| 6 | С | 3' - 0" | 6' - 8" | 0' - 2" | WOOD | PAINTED | NO | PUSH/PULL HDWR-PRIVACY LOCK | 4 | WOOD | PAINTED | A501-4 | |
| 7 | С | 3' - 0" | 6' - 8" | 0' - 2" | WOOD | PAINTED | NO | KEYED DOOR | 4 | WOOD | PAINTED | A501-4 | |
| 8 | A | 3' - 0" | 7' - 0" | 0' - 1 3/4" | STEEL | PAINTED | NO | KEYED EXT. PANIC | 1 | НМ | PAINTED | A501-1 | INSUL., WSTRIP, ACCESS THRESHOLD, CLOSER |
| 9 | С | 3' - 0" | 6' - 8" | 0' - 2" | WOOD | PAINTED | NO | KEYED PANIC | 4 | WOOD | PAINTED | A501-4 | |
| 10 | A | 3' - 0" | 7' - 0" | 0' - 1 3/4" | STEEL | PAINTED | NO | KEYED EXT. PANIC | 1 | НМ | PAINTED | A501-1 | INSUL., WSTRIP, ACCESS THRESHOLD, CLOSER |
| 11 | С | 3' - 0" | 6' - 8" | 0' - 2" | WOOD | PAINTED | NO | PUSH/PULL HDWR | 4 | WOOD | PAINTED | A501-4 | |
| 12 | С | 3' - 0" | 6' - 8" | 0' - 2" | WOOD | PAINTED | NO | KEYED DOOR | 4 | WOOD | PAINTED | A501-4 | |
| 13 | В | 3' - 0" | 6' - 8" | 0' - 1 3/4" | STEEL | PAINTED | NO | KEYED EXT. DOOR | 2 | НМ | PAINTED | A501-2 | INSULATED, WSTRIP, THRESHOLD |
| 14 | С | 2' - 8" | 6' - 8" | 0' - 2" | WOOD | PAINTED | NO | KEYED DOOR | 4 | WOOD | PAINTED | A501-4 | MUST EXIT FROM BASEMENT |
| 15 | С | 2' - 8" | 6' - 8" | 0' - 2" | WOOD | PAINTED | 3/4 HOUR | KEYED DOOR | 3 | WOOD | PAINTED | A501-3 | MUST EXIT FROM BASEMENT |
| 16 | Α | 3' - 0" | 7' - 0" | 0' - 1 3/4" | STEEL | PAINTED | NO | KEYED EXT. DOOR | 2 | НМ | PAINTED | A501-2 | INSULATED, WSTRIP, |



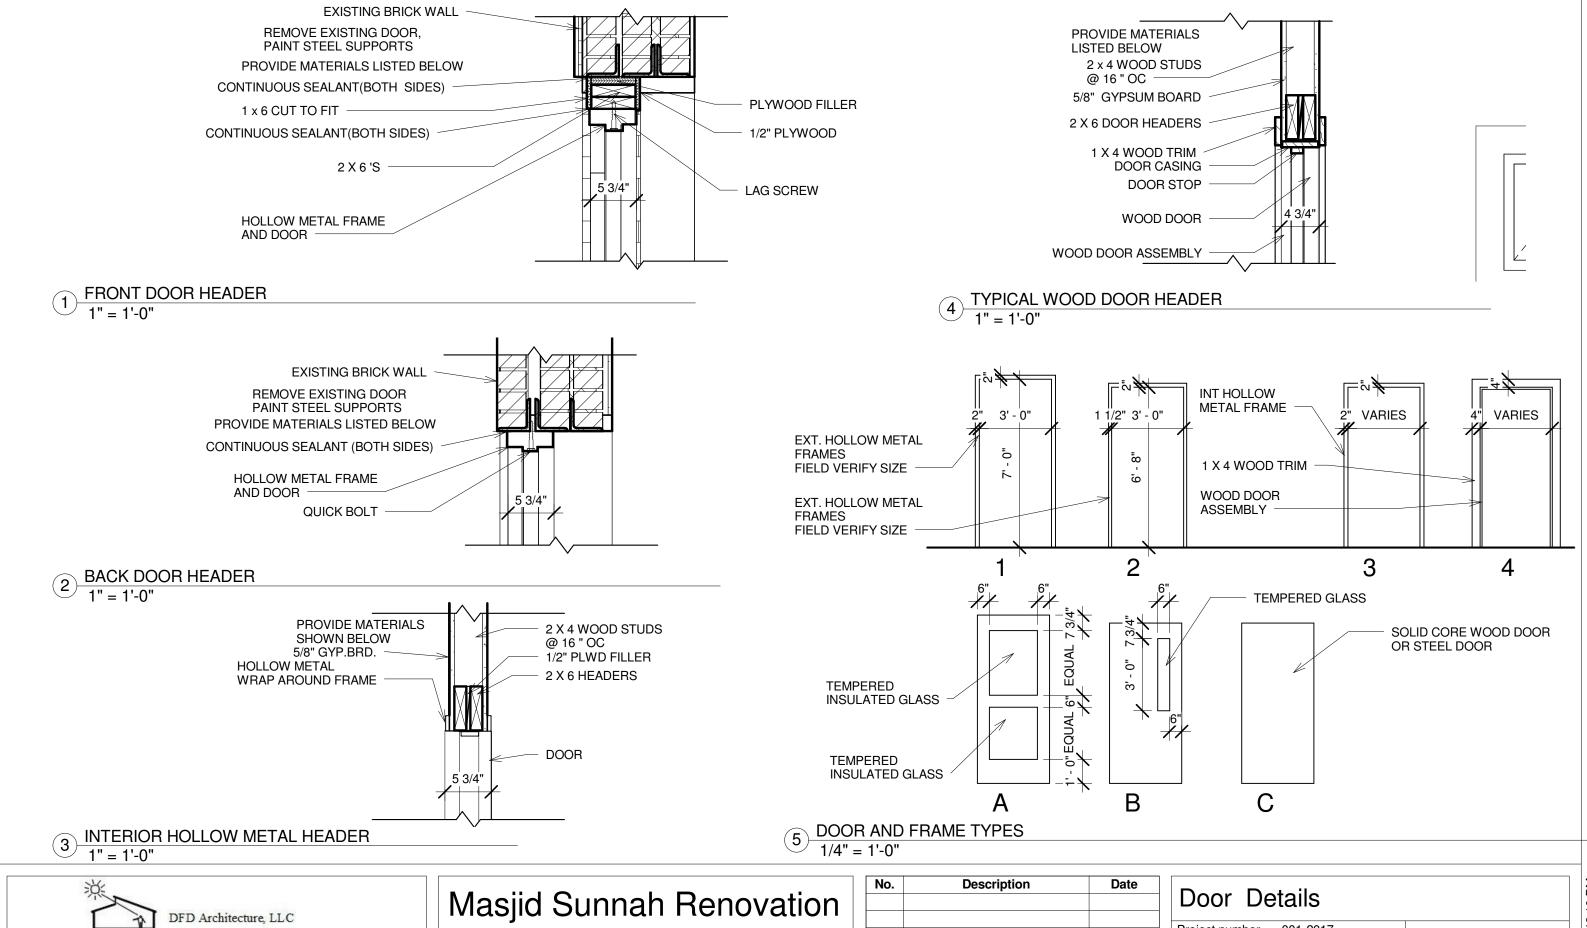
DFD Architecture, LLC

dfdarchitecture@gmail.com PO Box 182, Spring Lake, MI 49456 616 821 0936 Masjid Sunnah Renovation 2312 South Division, Grand Rapids, MI 49507

| No. | Description | Date |
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| Door Scl | hedule | | |
|----------------|-----------|-------------|--|
| Project number | 001-2017 | | |
| Date | 6/11/2018 | A500 | |
| Drawn by | Author | 7 1000 | |
| Checked by | S | Scale | |
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THRESHOLD



DFD Architecture, LLC

dfdarchitecture@gmail.com

PO Box 182, Spring Lake, MI 49456
616 821 0936

| No. | Description | Date | |
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| Door De | etails | | |
|----------------|-----------|--------------------|---|
| Project number | 001-2017 | | - |
| Date | 6/11/2018 | A501 | |
| Drawn by | Author | 7 (3 3 1 | |
| Checked by | t | Scale As indicated | 1 |
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| | | | | Room Schedule | | | |
|-------------|--------------------|------------------------------|-----------------------------------|--|------------------------------------|----------------|--|
| Room Number | Room Name | Floor Finish | Base Finish | Wall Finish | Ceiling Finish | Ceiling Height | Comments |
| 1 | UNISEX | Vinyl Plank | Vinyl | Paint Gyp. Board, Repair and Paint Plaster | Gypsum Board/Accoustical Tile | 8' - 6" | |
| <u>)</u> | ENTRY | Vinyl Plank | Vinyl | Paint Gyp. Board, Repair and Paint Plaster | Gypsum Board/Accoustical Tile | 8' - 6" | |
| 3 | JANITOR | Vinyl Plank | Vinyl | Paint Gyp. Board, Repair and Paint Plaster | Gypsum Board, Finished and Painted | 11' - 2" | |
| 3 | JAN | | | | | | |
| | MEN'S | Vinyl Plank | Vinyl | Paint Gyp. Board, Repair and Paint Plaster | Gypsum Board/Accoustical Tile | 8' - 6" | |
| | WOMEN'S WORSHIP | Nylon Comm. Carpet w/ Pad | Wood Base to match existing | Paint Gyp. Board, Repair and Paint Plaster | Gypsum Board, Finished and Painted | 11' - 2" | New Gypsum Board on North Wall |
| 3 | BOOKSTORE | Vinyl Plank | Wood Base to match w shoe molding | Paint Gyp. Board, Repair and Paint Plaster | Gypsum Board, Finished and Painted | 11' - 2" | |
| , | VESTIBULE | Vinyl Plank | Vinyl | Paint Gyp. Board, Repair and Paint Plaster | Gyp Board/Accoustical Tile | 8' - 6" | |
| 3 | MEN'S WORSHIP | Nylon Comm. Carpet w/ Pad | Wood Base to match existing | Paint Gyp. Board, Repair and Paint Plaster | Gypsum Board, Finished and Painted | 11' - 2" | Remove Floor Grates and patch with 3/4" plywood panels |
|) | OFFICE | Vinyl Plank | Vinyl | Paint Gyp. Board, Repair and Paint Plaster | Gypsum Board, Finished and Painted | 11' - 2" | |



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| No. | Description | Date |
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| Room Schedule | | | | |
|----------------|-----------|----------|--|--|
| Project number | 001-2017 | | | |
| Date | 6/11/2018 | A502 | | |
| Drawn by | Author | 7 (3 3 2 | | |
| Checked by | u | Scale | | |
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